





ROOF PLAN
SCALE 1:100

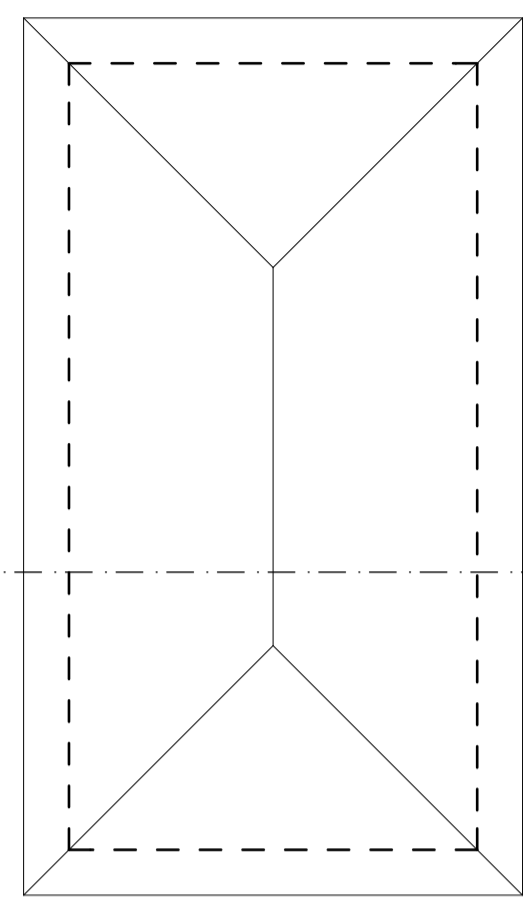


ELEVATION 03
SCALE 1:100

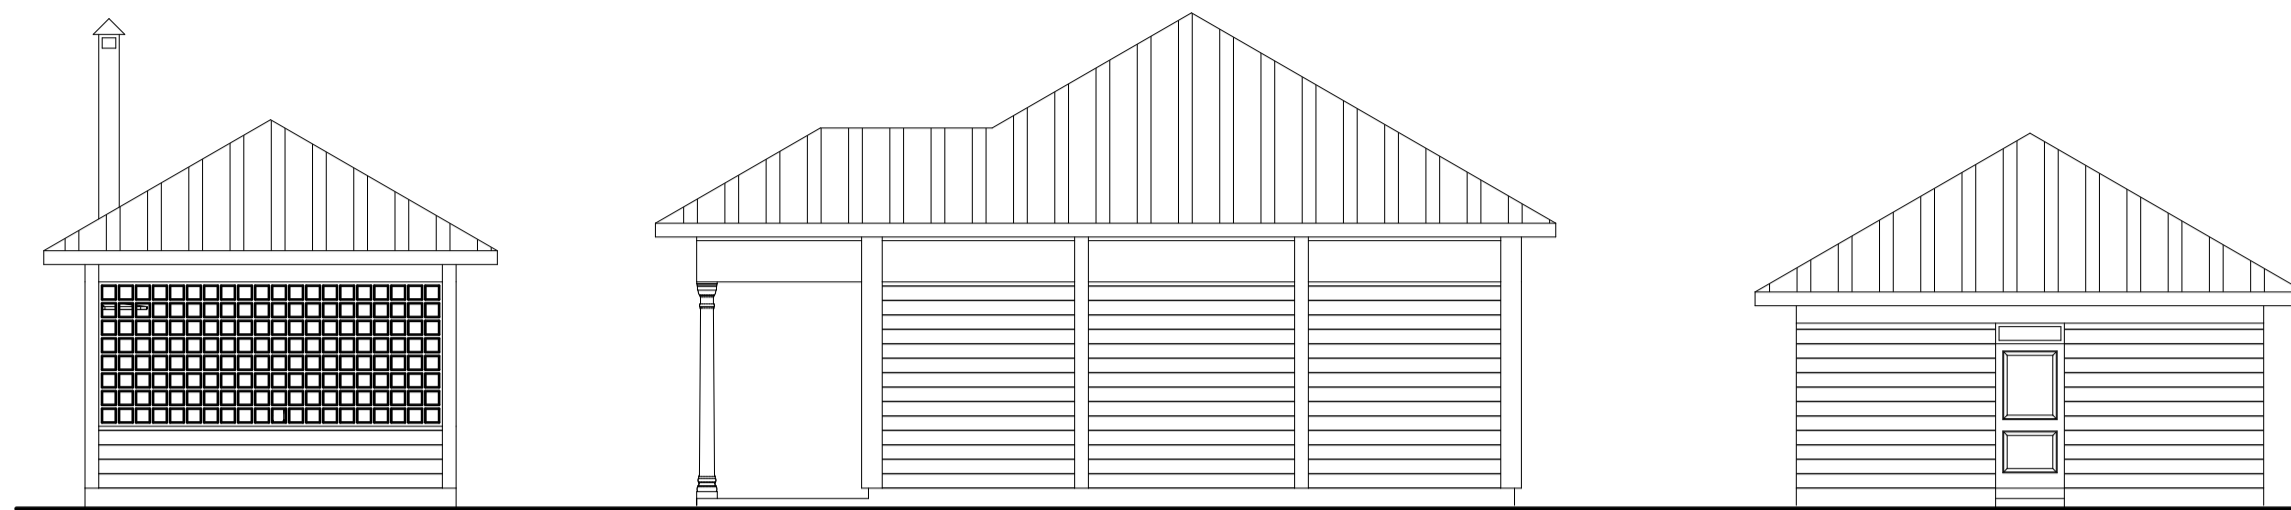


ELEVATION 01
SCALE 1:100

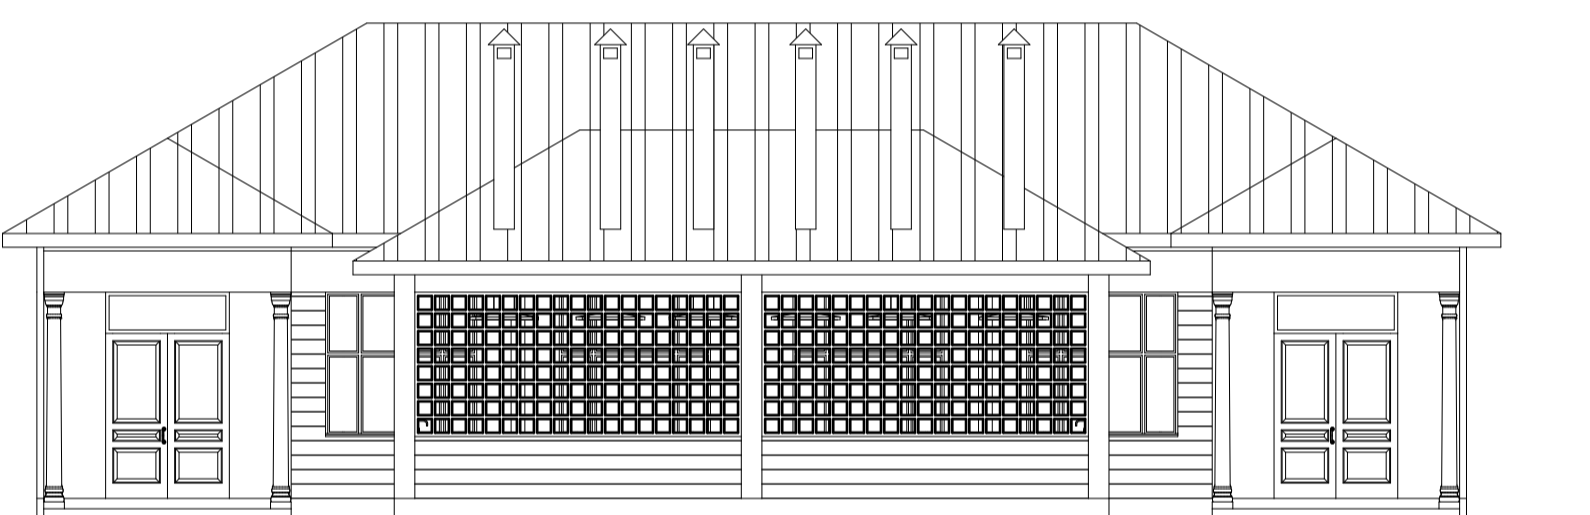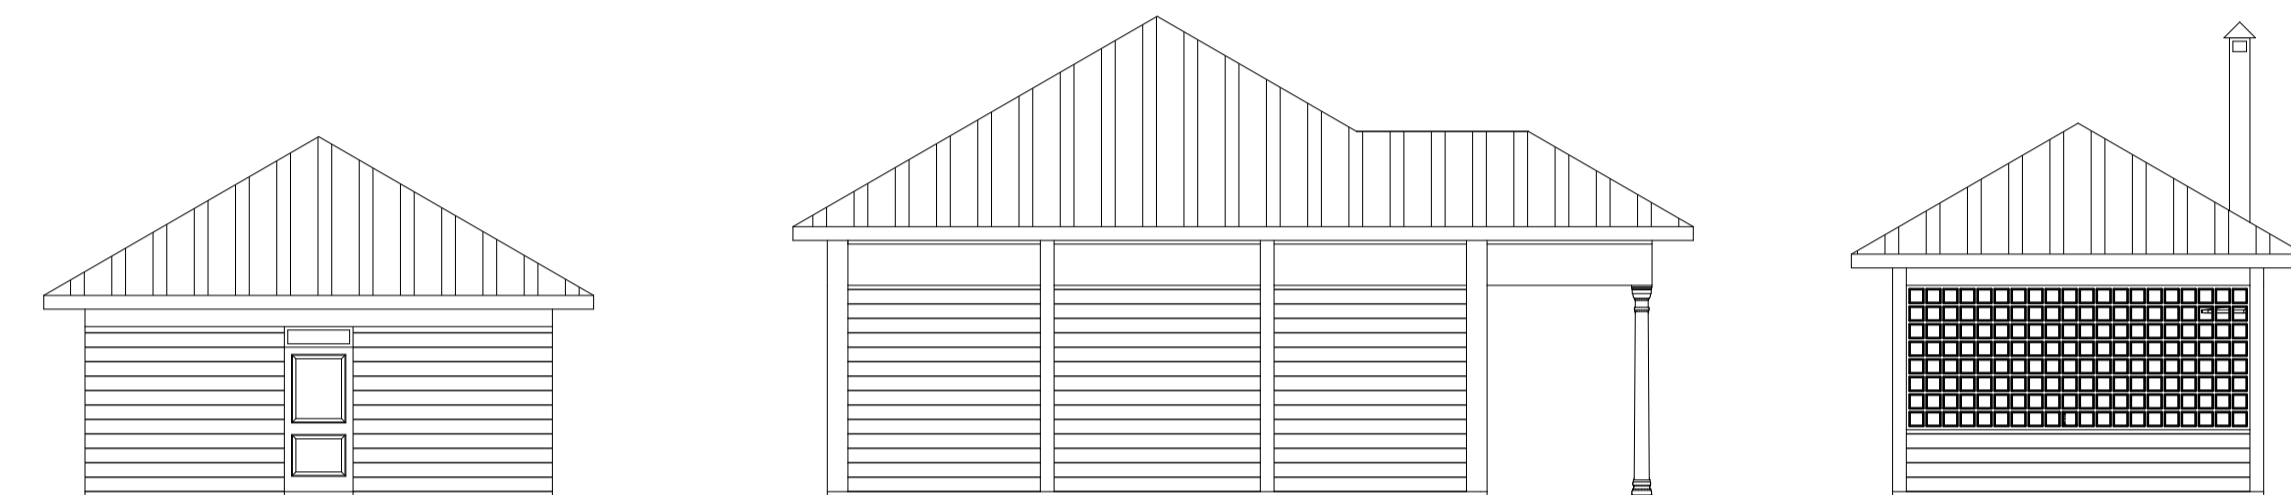

ELEVATION 04
SCALE 1:100

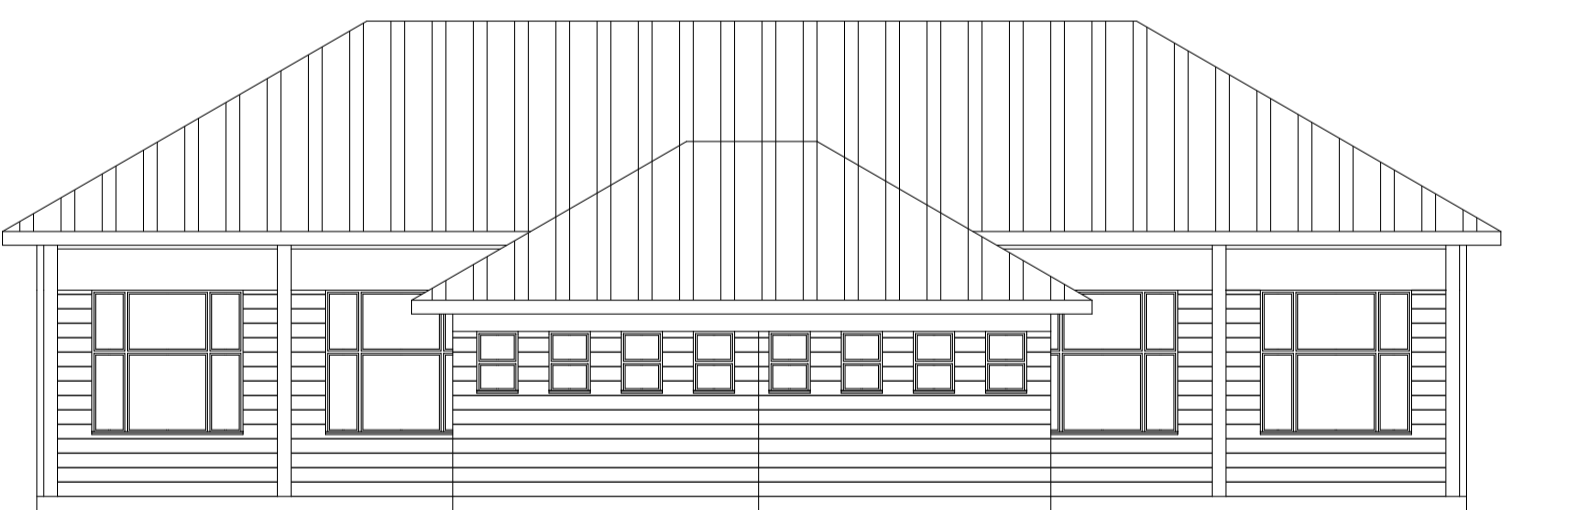


ELEVATION 02
SCALE 1:100

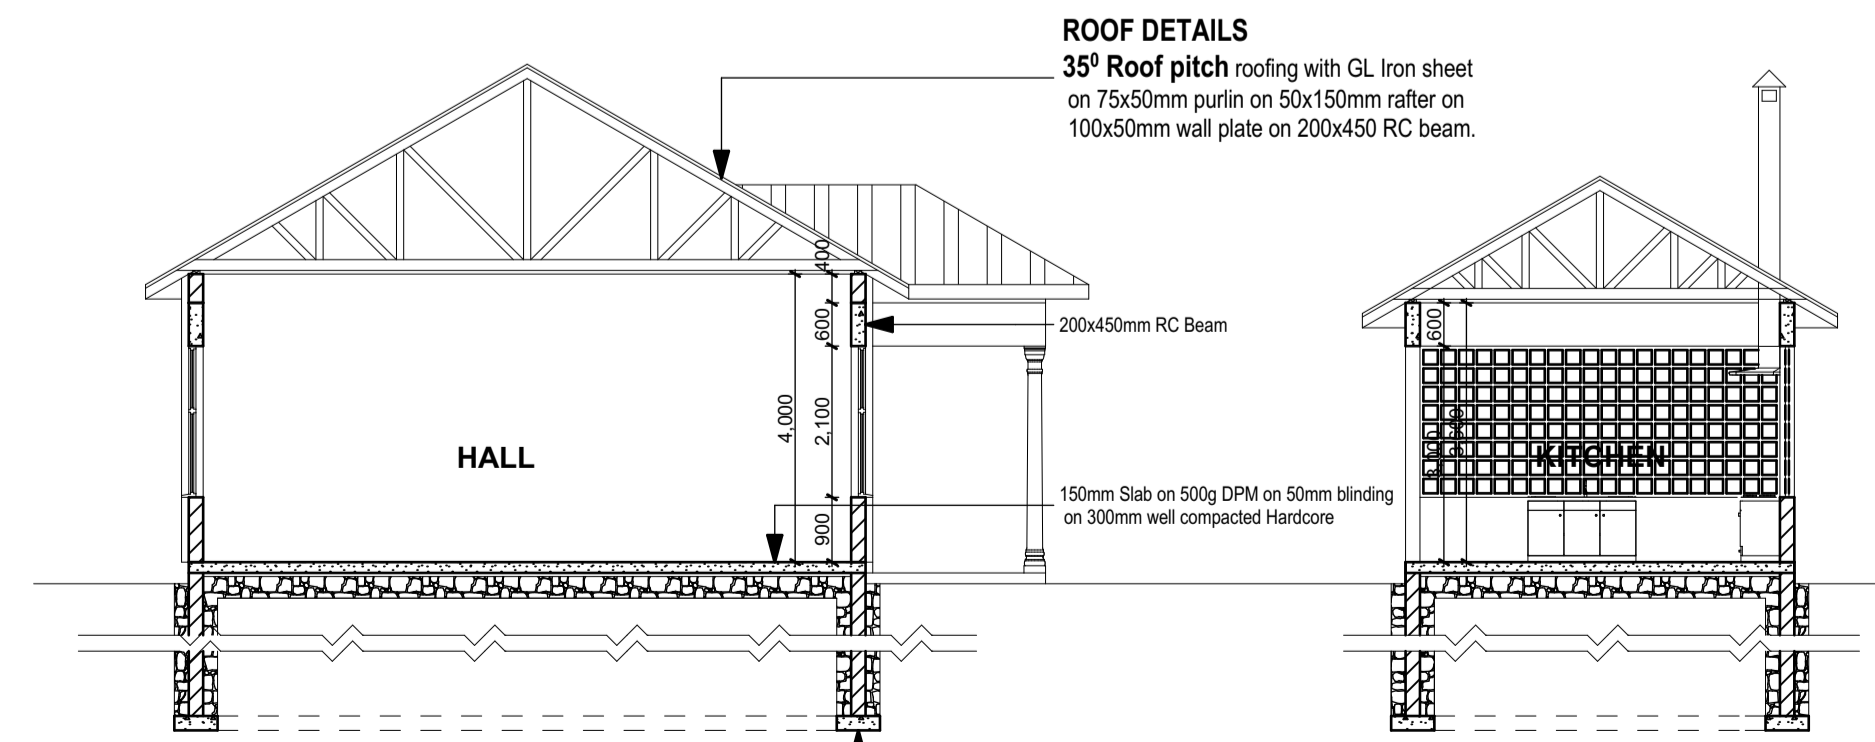


SECTION X-X
SCALE 1:100

ROOF DETAILS
35° Roof pitch roofing with GL Iron sheet on 75x50mm purlin on 50x150mm rafter on 100x50mm wall plate on 200x450 RC beam.

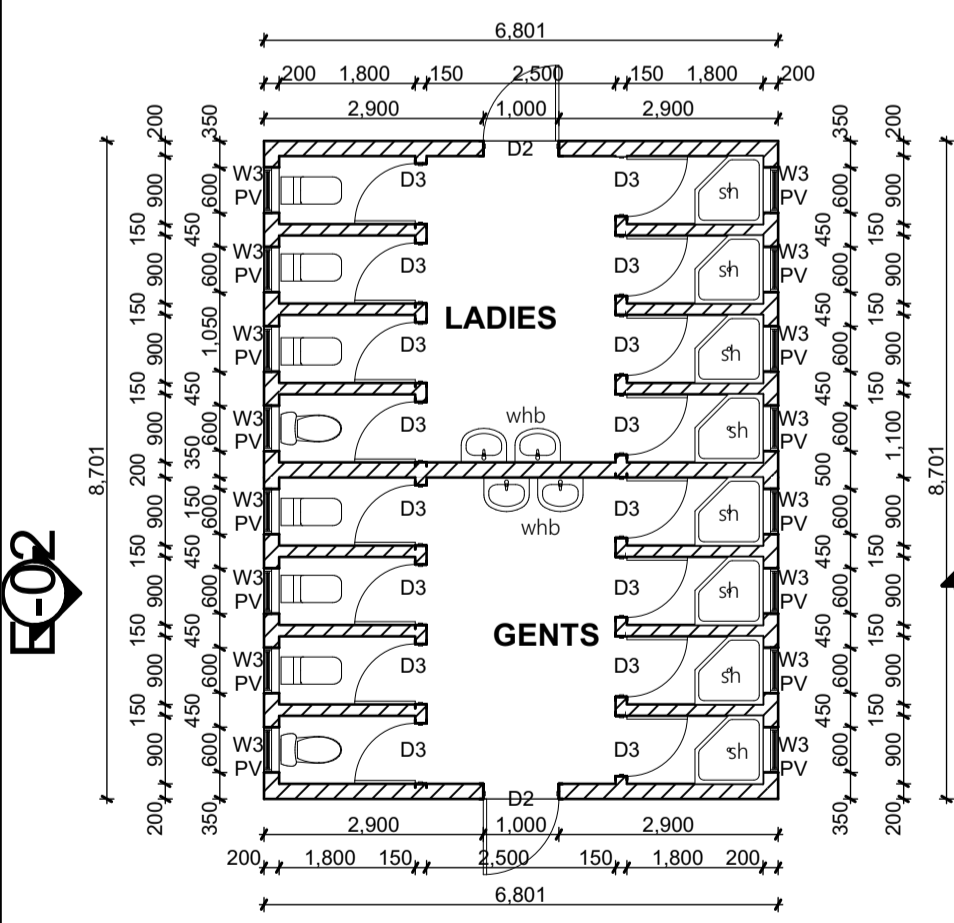

ABLUTION BLOCK
SCALE 1:100

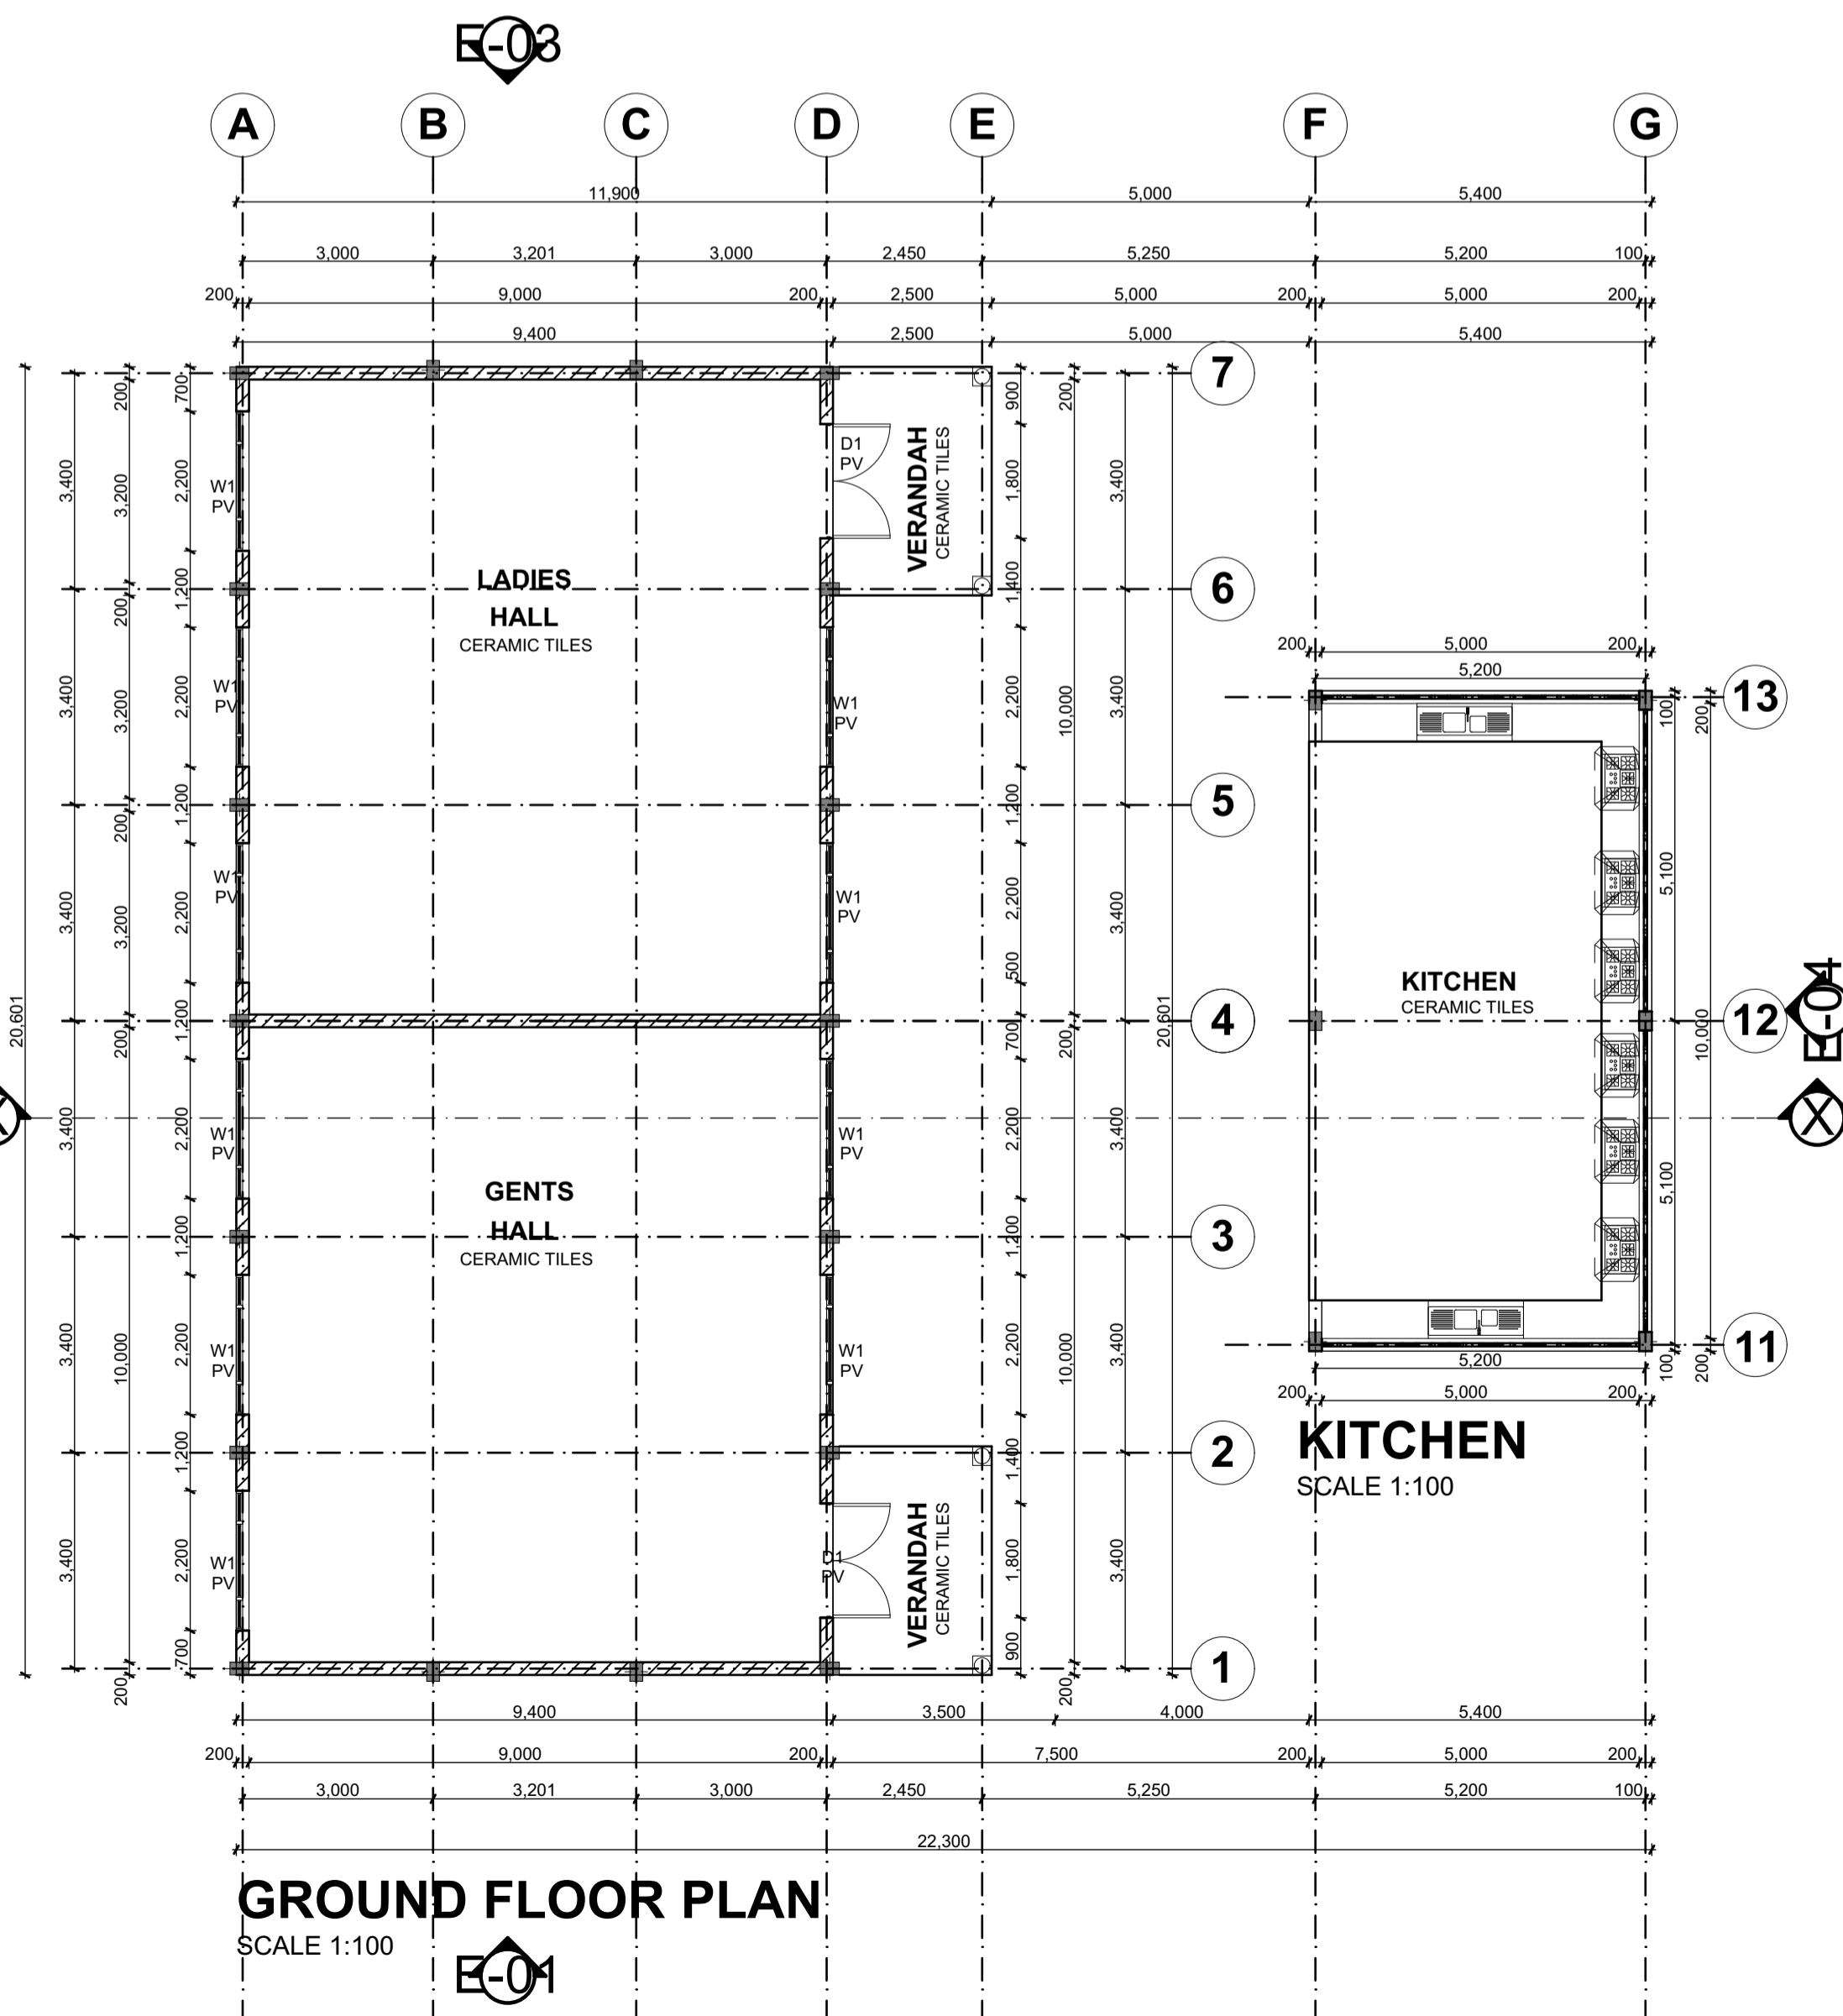

GROUND FLOOR PLAN
SCALE 1:100

NOTES

- All dimensions in millimetres unless stated otherwise.
- Foundation depth to be determined on site.
- Provide P.V above all openings.
- Provide D.P.C. below all walls.
- Foundations not to encroach neighbouring plots.
- Ground floor slab level to be determined on site by lead consultant.
- All walls less than 200mm thock to be reinforced with hoop iron at every alternate course.
- All reinforced concrete works to be in accordance with S.E.s specifications.
- All sanitation works to be in accordance with Ministry Of Health rules.
- Where drainages pass under buildings or driveways, pipe to be encased in 150mm concrete surround or to be of cast iron.
- Water meter to be positioned at least 300mm above ground level.

DOORS & WINDOWS SCHEDULES

DOORS

CODE	WIDTH	HEIGHT	No.	DESCRIPTION
D1	1800	2400	2	PANEL DOOR
D2	900	2400	2	FLUSH DOOR WITH SOLID CORE
D3	800	2400	16	FLUSH DOOR WITH SOLID CORE

WINDOWS

CODE	WIDTH	HEIGHT	No.	DESCRIPTION
W1	2200	2100	10	STEEL CASEMENT
W3	600	900	16	STEEL CASEMENT

AREA

HALL	= 211.647M ²
KITCHEN	= 56.156M ²
ABLUTION BLOCK	= 30.263M ²

project:

PROPOSED EVACUATION CENTRE ON PLOT NO. - KISUMU COUNTY

client

VIRED INTERNATIONAL,
P.O BOX ,
KISUMU

owner's signature

title

PLANS, ELEVATIONS,
SECTION

consultant
VAST ENGINEERING & LOGISTICS LIMITED
P.O BOX 3693
ELDORRET.
0721 204 807 , 0733 879 898

scale
1: 100 ,

date
NOV. 2019

drg no.
VEL/2019/62